





This is an artistic representation of the design. It is not intended to be an exact rendition.

PROJECT:

PAHK RESIDENCE

LOCATION:

93 Raymond Ave Somerville, MA 02144

PREPARED BY:

Francis Harvey Remodeling, LLC 697 Hartford Turnpike Shrewsbury, MA. 01545

DATE:

2/7/2018

REVISION DATE:

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PROJECT

Caroline and Joon Pahk

93 Raymond Ave Somerville, MA 02144

CONTRACT PLANS			
APPROVED BY:			
APPROVED BY:			
DATE : 2/7/2018	REVISION DATE:		
	PRINTED ON:		

5/16/2018

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COVER PAGE

GENERAL NOTES

- 1. Removal of and disposal of job related debris from site.
- 2. Provide temporary toilet for staff unless arranged otherwise.
- 3. "Broom Clean" new work area at the end of each work day and keep job site in a clean and orderly manner.
- 4. Provide work site message center per arrangement with owner.
- 5. Provide job schedule for general phases of the project.
- 6. Hold weekly meetings with owner to assess project schedule and progress of job.

EXISTING CONDITIONS

These plans and specifications call for the installation of new construction components or modification to existing components. It is assumed that the existing structure is code-compliant and will function properly with these newly installed components. Modification of the pre-existing structure and its effect on newly installed components is not included unless otherwise noted.

MATERIALS (Non-Hazardous)

Francis Harvey Remodeling, LLC retains ownership of all excess building products and supplies (overstock) and demolished materials. Remaining non-hazardous materials and demolished debris will be removed from the jobsite.

OWNER SUPPLIED MATERIALS/ITEMS

Home owner is responsible for delivery, inspection, storage, and assembly of all home owner supplied items or materials from delivery to installation.

LEAD & HAZARDOUS MATERIALS

The cost to perform work in accordance with lead safe and/or hazardous material removal work practices will be evaluated at time of discovery unless otherwise noted. In the event that Hazardous materials are encountered, a cost assessment will be made and presented to the homeowner for approval prior to demolition or removal (excluding any that are specifically identified in this Construction Agreement.)

DEMOLITION

All demolition performed assumes removal of a single layer of material unless otherwise noted. This includes but not limited to siding, roofing, drywall, flooring, wall, and ceiling coverings unless specifically stated otherwise.

SELF PERFORMED WORK

For scheduling and logistical purposes, no work shall be performed independent of Francis Harvey Remodeling, LLC without the written approval of Francis Harvey Remodeling, LLC.

EXCAVATION

Excavation to include work associated with the digging out of soil. This work assumes that there is no ledge or boulders larger than 6" in diameter for hand excavation and 1/8 yd for machine excavation unless otherwise noted. It is assumed that the ground is composed of suitable load bearing soils, free of organic matter, non-compacted back fill or expansive soils. Excavation will not begin without DIGSAFE marking underground lines from utility companies. All private lines, including landscaping sprinkler, septic and wells, must be identified by the client. Relocating, repairing or special measures such as hand work, of any and all private lines and/or utility lines is excluded unless specifically noted. An additional work order will be presented for hand excavation and/or repair of such lines shall be presented to the client upon discovery. It is assumed that excavation to the required depth can occur without ground water mitigation. In the event that ground water is encountered, Francis Harvey Remodeling, LLC will present a proposal for any additional work and/or engineering for remediation of unsuitable soils to the client.

FRAMING

Framing lumber will consist of K-D (kiln-dried) lumber which is typically shipped with a moisture content of 19%. The framing material eventually dries to 6% - 11% in a completed building. This is a normal process that may cause shrinkage which can create drywall cracks and settling. Repairs to drywall due to this settling is the responsibility of the client. This will typically present, if at all, in the first few years of ownership. It is a normal condition that can be easily attended to with plaster and paint when/if encountered.

ROOFING

ROOFING EXISTING STRUCTURE: It is assumed that the existing roof deck is in an acceptable condition to attach new roofing. It is also assumed that the existing roof is properly ventilated.

SIDING

SIDING EXISTING STRUCTURE: It is assumed that the existing wall sheathing is in an acceptable condition to attach new siding.

COUNTERTOPS

Unless otherwise provided here-in, due to material veining, size, and yield, the final seam location will be determined by the installer/manufacturer and Harvey Remodeling LLC at time of fabrication. If the client desires specific seam locations it may result in additional costs. Natural stone and manufactured materials will vary in color, shading, and veining and may not be uniform. Customer is encouraged to view and acknowledge acceptance of slab(s) prior to fabrication. If customer chooses not to view product or sign acknowledgement, no claim of dissatisfaction due to variations between the sample seen and the stone delivered will be warranted.



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Caroline and Joon Pahk

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GENERAL NOTES

CABINETS AND CLEAR TRIMMORK

All woods exhibit variations in color, grain, and texture. These variations are often within the same cabinet or piece of wood. Different species exhibit different characteristics that are indicative of a natural wood.

RED OAK

Red oak has a prominent grain pattern and may exhibit noticeable differences between open and closed grain areas

MAPLE

Maple is known for its fine, uniform grain and texture. It has a natural color range from nearly white to reddish-brown. Mineral streaks occur naturally in maple and are not considered a defect.

CHERRY

Cherry ranges from nearly white, to light red, to dark reddish-brown. Black mineral streaks and very light to white gum spots are common in cherry and are not considered a defect. Cherry will darken over time, especially when exposed to sunlight.

HICKORY

Hickory has unpredictable patterns which include dark streaks. It has wide color variations from fairly white to shades of reddish dark brown.

LYPTUS

Lyptus has a wide variety of colorations and grain patters. It darkens considerable and rapidly as it ages.

HOOD VENTILATION

It is assumed that the hood can be ventilated directly to the outside and does not include modification of mechanical systems or structural items.

APPLIANCE RELOCATING, INSTALLATION AND/OR ASSEMBLY

Unless otherwise specified herein, a maximum of two hours has been allowed for the installation of appliances, assembly of appliances, modifications of other building components, or tie-ins to mechanical systems

ELECTRICAL

Electrical will be installed according to plans and electrical schedules. It is assumed that the existing wiring system is sufficient to accept proposed electrical layout and new ARC fault protectors. The exact placement of lights, outlets, switches, and other electrical features will be determined by the framing layout. Any modifications to structure to accommodate placement is not included unless otherwise noted. Assembly of fixtures is not included. All decorative lighting is be supplied assembled by client unless otherwise noted. All fixtures are assumed to be 110 volts. Low voltage wiring is not included unless otherwise noted. Moving of underground electrical lines is excluded unless otherwise specifically noted herein.

These plans and specifications call for the installation of new electrical components. It is assumed that the existing electrical system is code-compliant and will function properly with these newly installed components.

Troubleshooting and/or repair of the pre-existing electrical system and its effect on newly installed electrical and/or ARC-fault components is not included.

PLUMBING/HEATING/MECHANICAL SYSTEMS

Plumbing and heating and mechanical systems will be installed according to plans and schedules. It is assumed that the existing mechanical systems are sufficient to accept the proposed layout. The exact placement of fixtures will be determined by the framing layout. Any modifications to the structure to accommodate placement is not included unless otherwise specifically noted herein.

PAINTING

NEW TRIM Painting prep will consist of caulking of gaps in trim-work, filling nail holes and lightly sanding surfaces. All trim will have a prime coat plus two semi-gloss finish coats unless otherwise noted on finish schedule.

NEW MORK: New walls shall have one coat of primer and two coats of flat finish unless otherwise noted in finish schedule. New ceilings shall have one coat of primer and one coat of ceiling white paint.

RE-PAINTING EXISTING: For existing walls identified to be painted in the finish schedule, one coat of flat white finish paint will be applied unless otherwise noted on finish schedule. Painting prep will consist of no more than two hours of prep time per room unless otherwise noted. Prep includes caulking of gaps in trim-work, filling nail holes and lightly sanding surfaces. Should additional preparation be desired the home owner must make a written request prior to the painting of said surfaces and contractor will prepare an additional work order for homeowner's approval.

EXISTING TRIM: Prep will consist of lightly sanding existing finish not to exceed one hour per room unless otherwise noted in the finish schedule. It is assumed that the existing finish is properly bonded to trim-work and will not flake or peel once new finish is applied. Trim will be painted with one coat of satin white paint unless otherwise noted. Should additional preparation be desired the home owner must make a written request prior to the painting of said surfaces and contractor will prepare an additional work order for homeowner's approval.

MATCHING OF EXISTING MATERIALS AND FINISHES

Matching existing materials can be difficult. Materials may no longer be produced or may have faded with age. The Contractor will attempt to match existing; however, Contractor makes no warranty that it will result in an acceptable match. For stain applications, owner is TO APPROVE THE STAIN SELECTION AND SIGN SAMPLE PRIOR TO COMMENCEMENT OF WORK. Contractor makes no warranty that the homeowner approved sample will match existing.



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	5/16/2018		
GENERAL NOTES	5		

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CERTIFIED PLOT PLAN



hs&t group, inc.

PROFESSIONAL CIVIL ENGINEERS & LAND SURVEYORS
75 HAMMOND STREET - 2ND FLOOR
WORCESTER, MASSACHUSETTS 01610-1723
PHONE: 508-757-4944 EMAIL: INFO@HSTGROUP.NET


508-752-8895 WWW.HSTGROUP.NET

PROJECT: 93 RAYMOND AVE SOMERVILLE MA OWNER: CAROLINE PAHK

DATE: 02-02-18 DEED: 53082-289 PLAN: 160-50 MBL: 7-1-56-2 FLD. BK: 650-92 ZONE: RA SCALE: 1"=20' COMP'D: DJT CAD: DJT

JOB #: 6401 FILE: RAYMOND93PL

I CERTIFY THAT THIS PLAN FULLY AND ACCURATELY DEPICTS THE LOCATION OF THE BUILDING AND DIMENSIONS AS SHOWN.

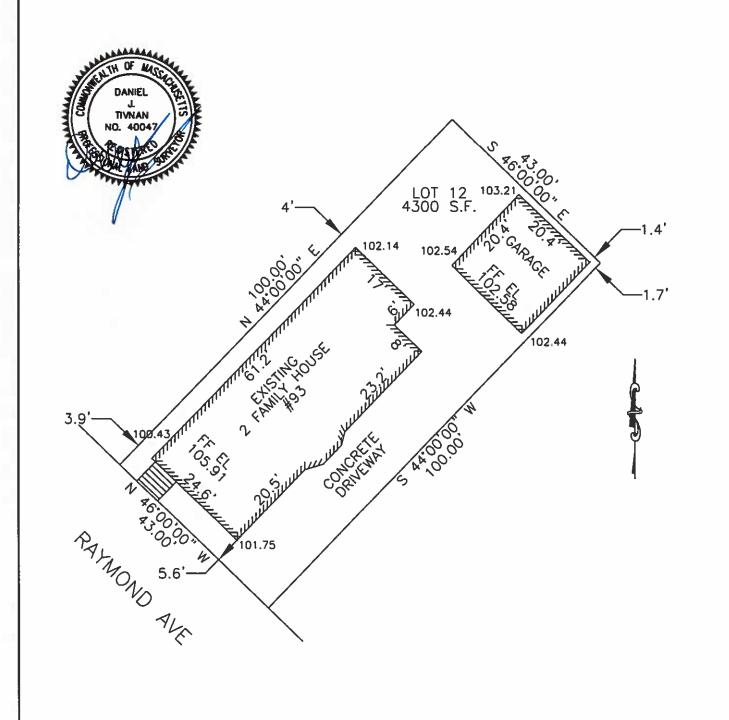

FAR CALCULATIONS

LOT AREA: 4,300.00 sq ft

BASEMENT: 290.00 sq ft 1st FLOOR: 1,139.38 sq ft 2nd FLOOR: 1,379.25 sq ft

2 1/2 FLOOR: 404.97 sa ft

3,213.60 sq ft

FAR: .7473

ALLOWABLE FAR: .75

HEIGHT OF BUILDING

ELEVATION: 102.14

102.44 101.75 100.43 406.76

AVE GRADE: 101.69

MAX HEIGHT: 135.69



PROJECT

Caroline and Joon Pahk

93 Raymond Ave Somerville, MA 02144

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5/16/2018

PLOT PLAN

SCALE: DRAWING #

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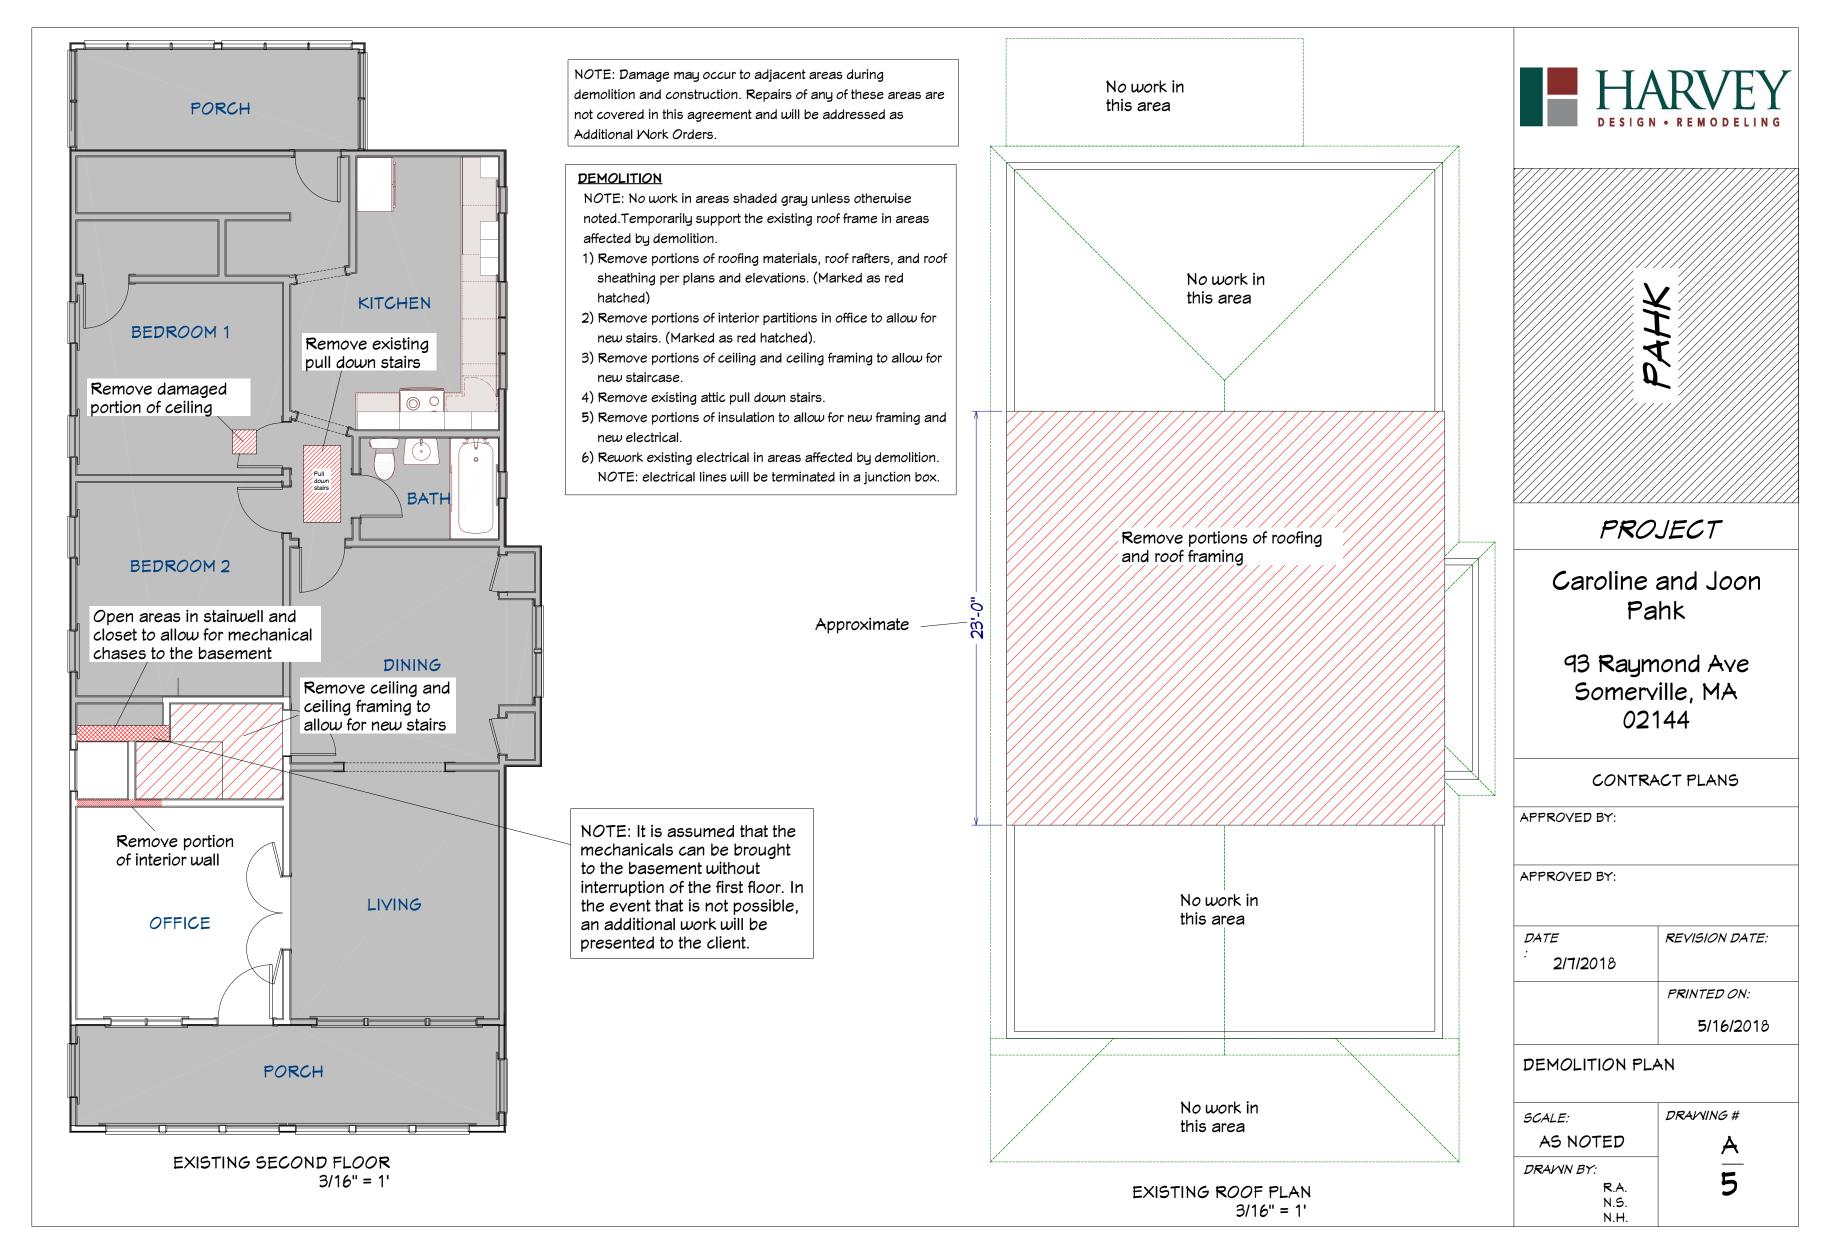
AVERAGE GRADE ELEV: 101.69


MAX. HEIGHT ELEV: 136.69

BUILDING HEIGHT

ELEV: 133.48






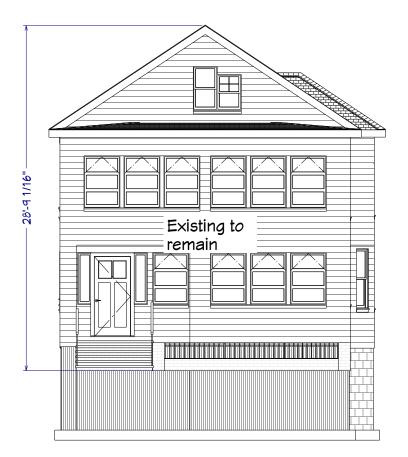


EXISTING FRONT ELEVATION
1/8" = 1'



EXISTING REAR ELEVATION 1/8" = 1'

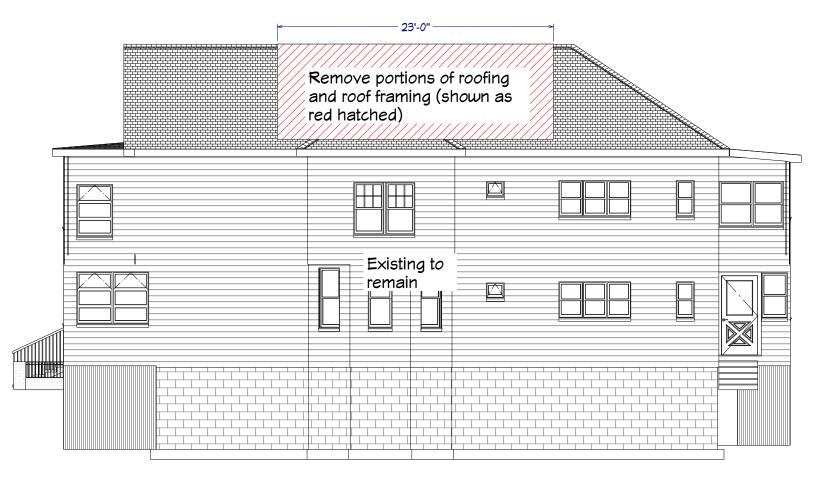

EXISTING RIGHT ELEVATION 1/8" = 1'

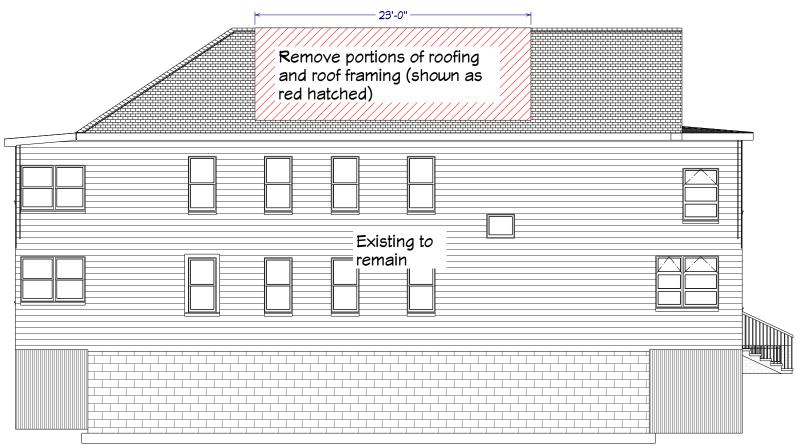


EXISTING LEFT ELEVATION
1/8" = 1'

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PROPOSED SECOND FLOOR 3/16" = 1'


CONSTRUCTION SCOPE

NOTE: No work in areas shaded gray unless otherwise noted.


- 1) Frame floor joists over existing ceiling joists per Framing plan and detail.
- 2) Install 3/4" T/G subfloor, glued and nailed with 8D ring shank nails in new spaces and in existing attic spaces.
- 3) Frame exterior walls with 2×6 wall construction, 1/2" sheathing, and Tuvek house wrap.
- 4) Frame roof per Roof Framing plan.
- 5) Install roof sheathing per framing plan.
- 6) Frame interior partitions per plans and wall types.
- 7) Frame new stairs from second floor to third floor per plans.
- 8) Frame in ceiling in area of old attic stairs.
- 9) Install new windows per plans and window schedule.
- 10) Install vinyl siding per plans and elevations. (Installed on new walls only)
- 11) Install EPDM roofing per plans and elevations. (Installed on new roof areas only)
- 12) Install electrical per plans and schedule.
- 13) Install new bath fan vent in new bath, vent to exterior.
- 14) Install plumbing feeds and drains to new bath fixtures. Tie into feeds and drains of the existing second floor unit.
- 15) Install new plumbing vents for new fixtures.
- 16) Install HVAC heat and air conditioning per HVAC plan and specifications page A-10
- 17) Insulate new walls with R-21 fiberglass batt insulation.
- 18) Insulate new ceiling with R-49 cellulose blown-in insulation.
- 19) Install 1/2" blue board and skim coat plaster to walls and ceilings. Walls will have a smooth finish. Ceilings and closet interiors will have a light textured finish.
- 20) Repair areas of existing ceilings per plans. NOTE: Repaired areas will be blended into existing textures and may not be an exact match
- 21) Repair areas of stairwell opened for mechanical chases to basement. NOTE: Repaired areas will be blended into existing textures and may not be an exact match.
- 22) Install treads, risers, skirts, and railing per Stair Detail page A-11
- 23) Install bathroom cabinets per plans and cabinet schedule.
- 24) Install counters per finish schedule.
- 25) Install bath fixtures per plans and finish schedule.
- 26) Install doors per plans and schedule.
- 27) Install primed 1 X 6 window and door header trim with Brosco B100 vertical trim to be similar to photo on A-9.
- 28) Install primed Brosco baseboard moulding B400 FJP.
- 29) Install one melamine closet shelf and one pole in new bedroom closets.
- 30) Install 2 1/4" oak plank flooring, sand and finish with three coats of oil finish.
- 31) Paint new walls with one primer coat and two finish coats.
- 32) Paint new ceilings with one primer coat and one finish coat.
- 33) Paint pre-primed trim two finish coats.
- 34) Paint doors with two finish coats.

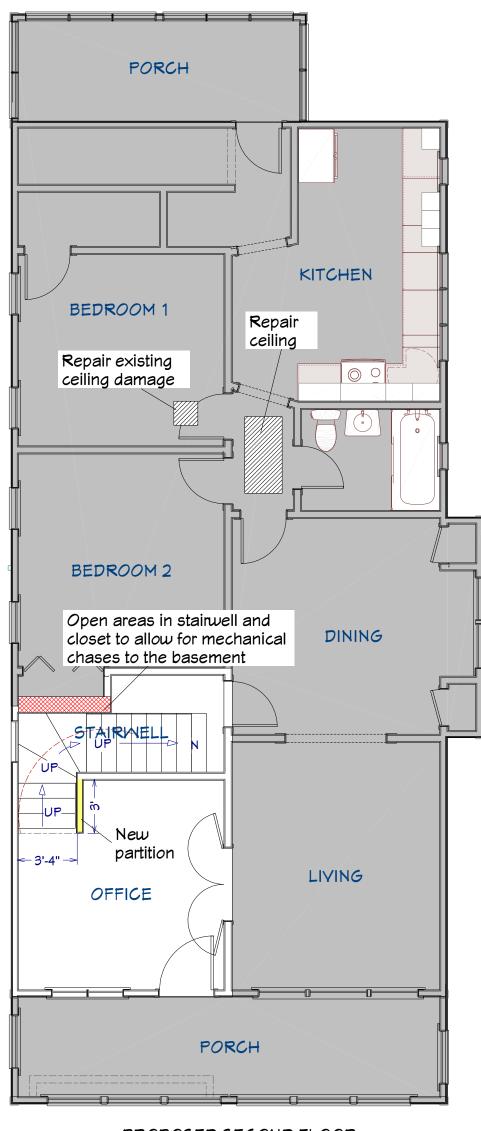EXISTING SECOND FLOOR PAINTING SCOPE

- 1) Paint ceiling with one primer coat and one finish coat in Bedroom 1, Hall, Stairwell, and Office.
- 2) Paint walls in Office and Stairwell (new and existing) with two finish coats, newly plastered areas will be primed with one coat.
- 3) Paint Office and new Stairwell trim with two finish coats.

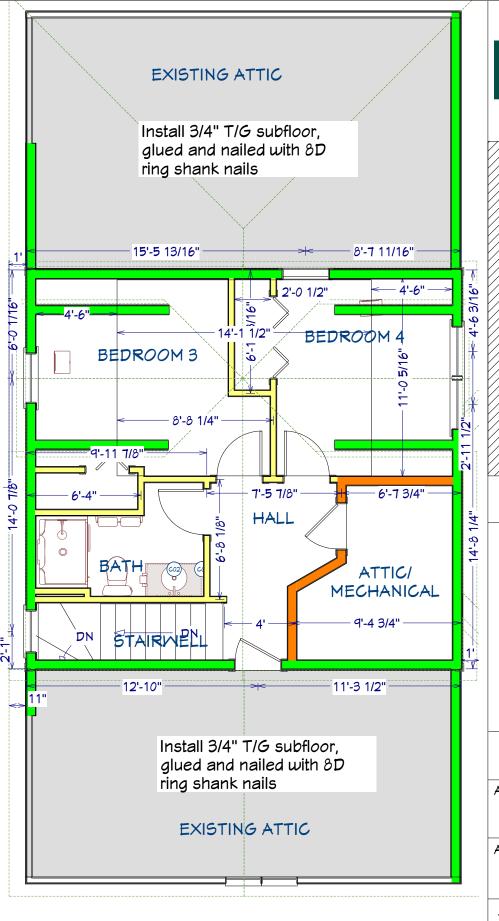

PROPOSED THIRD FLOOR 3/16" = 1'

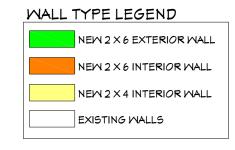



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PROPOSED SECOND AND THIRD FLOOR PLANS


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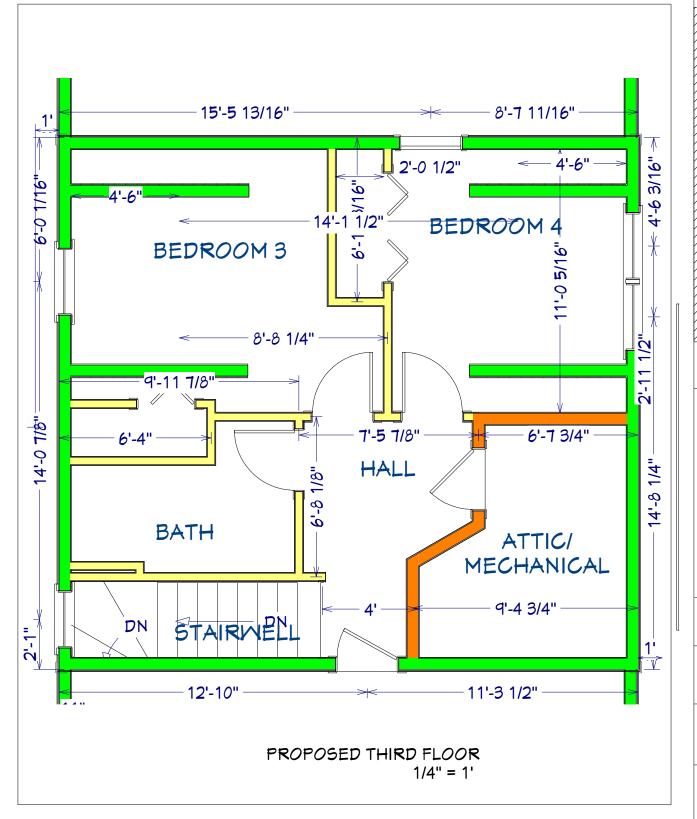
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PROPOSED THIRD FLOOR PLAN

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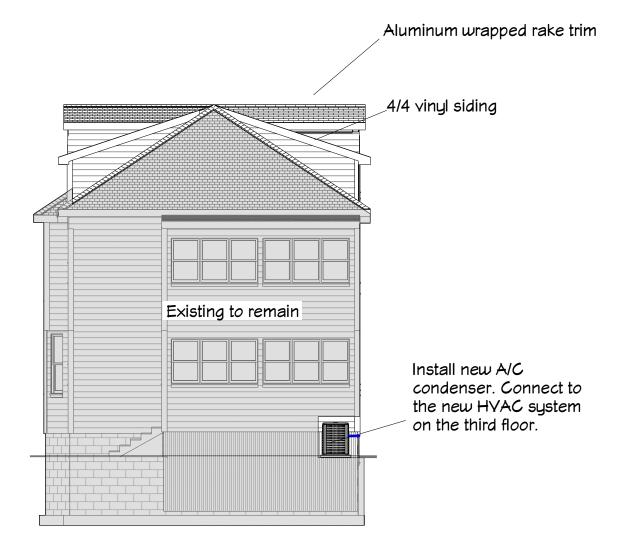
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PROPOSED EXTERIOR ELEVATIONS

SCALE: DRAWING #
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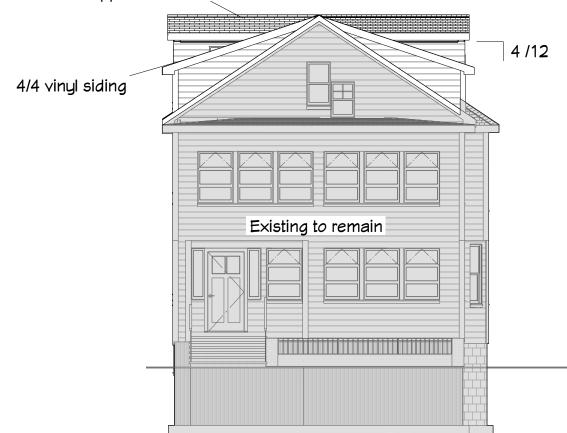
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PROPOSED REAR ELEVATION

1/8" = 1'


Aluminum wrapped rake trim

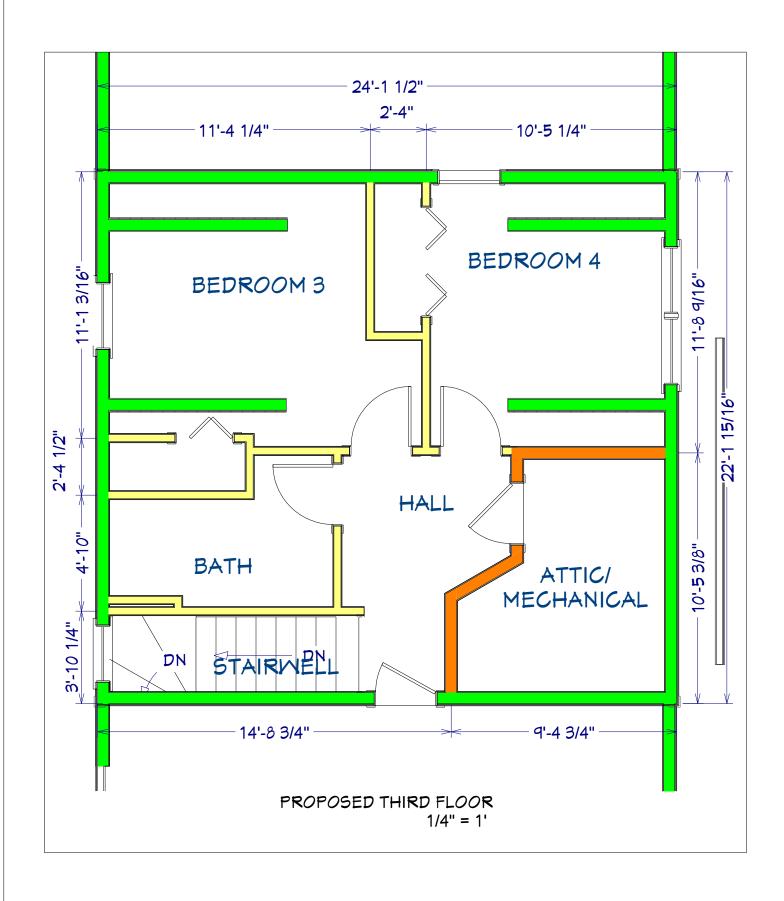


PROPOSED FRONT ELEVATION
1/8" = 1'

VINLY SIDING (New framing only)

- 1) Install house wrap over wall sheathing with taped seams. Wrap into window openings and tape over window flanges.
- 2) Install 3 1/3" vinyl outside corners, color to be "Autumn Yellow" or approved equal.
- 3) Install double 4" Certainteed Mainstreet vinyl siding, Color to be "Autumn Yellow" or approved equal.
- 4) Install vented T-4 vented vinyl soffit panels.
- 5) Wrap fascias and rakes with aluminum coil.

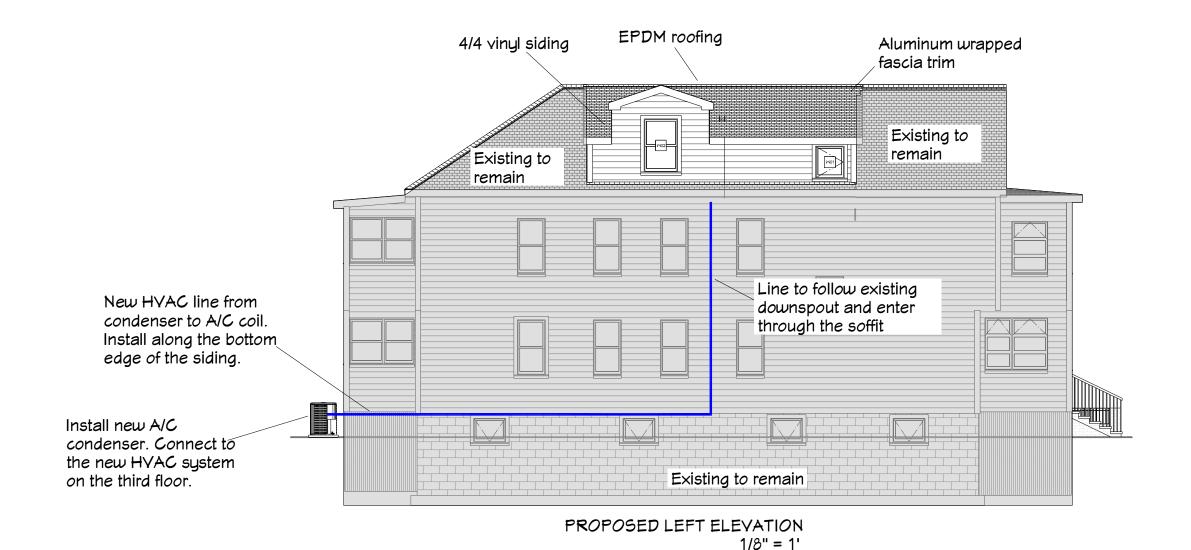

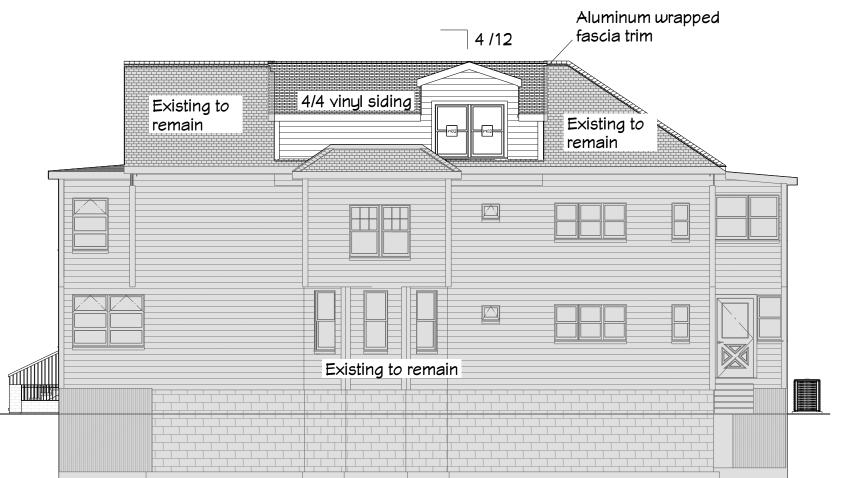

APPROVED BY: APPROVED BY: DATE REVISION DATE: 2/7/2018 PRINTED ON: 5/16/2018 PROPOSED EXTERIOR ELEVATIONS DRAWING # SCALE: AS NOTED DRAWN BY: R.A. PROPOSED RIGHT ELEVATION N.S. 1/8" = 1' N.H.



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93 Raymond Ave Somerville, MA 02144

CONTRACT PLANS

Finish Schedule/Selections List

3rd Floor Bath:

Cabinets: Showplace EVO— "Chesapeake" — Paint grade — Soft Cream. 5pc headers, full extension drawers, soft close doors and drawers.

Countertops: Swanstone - "Tahiti Desert" solid surface counter with integrated sink, back and side 4" splash.

Faucets (1): Kohler "Forte - Traditional" –Widespread sink faucet with traditional lever handles

#K-10272-4A-CP - Polished Chrome

Shower Unit: Sterling – "Accord" 48" x 36" #7226-0100 – White 4-piece modular "Vikrell" acrylic shower unit with center drain.

Shower Fixtures: <u>Kohler</u> – "Forte - Traditional" Valve trim and 2.5 gpm showerhead #K-TS10276-4A -CP – Polished Chrome. Rite Temp Valve #K-304-K-NA

Toilet: Kohler – "Corbelle" comfort height, elongated, 2 pc toilet, 1.28 gpf #K-3814-0 White. "Reveal" grip tight, quiet-close, elongated toilet seat #K-4008-0 White.

Tile: Floor -Place holder - Hex Matte White Porcelain Mosaic

Tile - 2 x 2 in.

By: Fired Earth Ceramics From "The Tile Shop" Grout: Whisper Grey From: "The Tile Shop"

Vanity Lighting: Kohler – "Forte" – Transitional double wall

sconce #K-11366-CP - Polished Chrome

Bath Accessories: <u>Kohler</u> – "Forte - Traditional" – Polished Chrome

- Toilet Paper Holder #K11274-CP
- -24" Towel Bar #K11271-CP
- -Customer provided surface mounted mirror

Paint: Sherwin Williams Walls: Satin finish, color TBD Trim: Semi-Gloss, Color TBD Ceiling: Flat Ceiling white

Finish Schedule/Selections List

3rd Floor Bedrooms and Hall:

Flooring: 2 1/4" Red Oak flooring, sanded and finished with three coats of oil polyurethane, Sheen TBD

Paint: Walls, trim, ceiling – Sherwin Williams – Color TBD


	ELECTRICAL SCHEDULE				
NUMBER	QTY	FLOOR	DESCRIPTION	COMMENTS	
E01	1	2	SINGLE POLE		
E02	1	3	BATH FAN/LIGHT COMBINATION	PANASONIC MODEL FV-11VQL6, 110 CFM	
E03	1	3	COISMOKE DETECTOR	HARDWIRE INTO EXISTING SECOND FLOOR CIRCUIT	
E04	1	3	HVAC POWER AND CONTROL WIRING FOR FURNACE, CONDENSER, AND AIR HANDLER		
E05	1	3	GFCI		
E06	7	3	SINGLE POLE		
E07	4	3	SURFACE MOUNTED FIXTURE	CUSTOMER PROVIDED	
E08	11	3	DUPLEX		
E09	1	3	VANITY LIGHT	KOHLER FORTE PER FINISH SCHEDULE	
E10	2	3	SMOKE DETECTOR	HARDWIRE INTO EXISTING SECOND FLOOR CIRCUIT	
E11	2	3	THREE WAY		
E12	2	3	FLOURESCENT CLOSET LIGHT		
E13	1	3	SUB-PANEL REUN OFF OF EXISTING ELECTRICAL SERVICE		

	CABINET SCHEDULE								
NUMBER	LABEL	QTY	FLOOR	MIDTH	DEPTH	HEIGHT	DESCRIPTION	MANUFACTURER	COMMENTS
C01	BF221	1	3	1 1/2 "	21 "	36 "	FILLER		
C02	FA.2TVSD3621	1	3	36 "	21 "	36 "	TALL COMBINATION SINK AND DRAWER BASE	SHOWPLACE EVO	FLUSH RIGHT

TO BE FIELD VERIFIED AND MAXIMIZED FOR HEIGHT. MDO PANEL WITH RIGID INSULATION FASTENED TO BACK SIDE, ACTUAL SIZE						DOOR SCHEDULE		
1 3 30 " 60 " FLUSH PRIMED PANEL, SOLID CORE, SOLID JAM HARVEY INDUSTRIES TO BE FIELD VERIFIED AND MAXIMIZED FOR HEIGHT. MDO PANEL WITH RIGID INSULATION FASTENED TO BACK SIDE, ACTUAL SIZE TO BE FIELD VERIFIED AND TO BE FIELD VERIFIED AND	NUMBER	RQTY	FLOOR	MIDTH	HEIGHT	DESCRIPTION	MANUFACTURER	COMMENTS
1 3 30 " 40 " STATIONARY ACCESS PANEL INSULATION FASTENED TO BACK SIDE, ACTUAL SIZE TO BE FIELD VERIFIED AND	D01	1	3	30 "	60 "	FLUSH PRIMED PANEL, SOLID CORE, SOLID JAM	HARVEY INDUSTRIES	STRIPPING, ACTUAL SIZE TO BE FIELD VERIFIED AND
	D02	1	3	30 "	40 "	STATIONARY ACCESS PANEL		INSULATION FASTENED TO BACK SIDE, ACTUAL SIZE TO BE FIELD VERIFIED AND
2003 4 3 30 " 80 " 2 RECESSED PANEL MDF DOOR PRC22 HARVEY INDUSTRIES PRIMED JAMS, MDF PANELS, SOLID CORE	D03	4	3	30 "	80 "	2 RECESSED PANEL MDF DOOR PRC22	HARVEY INDUSTRIES	· ·
1 3 28 1/8 " 80 " 2 RECESSED PANEL MDF DOOR PRC22 BIFOLD DOORS HARVEY INDUSTRIES PRIMED JAMS, MDF PANELS, SOLID CORE	D04	1	3	28 1/8 "	80 "	2 RECESSED PANEL MDF DOOR PRC22 BIFOLD DOORS	HARVEY INDUSTRIES	1
205 1 3 54" 80" 2 RECESSED PANEL MDF DOOR PRC22 BIFOLD DOORS HARVEY INDUSTRIES PRIMED JAMS, MDF PANELS, SOLID CORE	D05	1	3	54 "	80 "	2 RECESSED PANEL MDF DOOR PRC22 BIFOLD DOORS	HARVEY INDUSTRIES	

	MINDOM SCHEDULE								
NUMBER	LABEL	QTY	FLOOR	MIDTH	HEIGHT	EGRESS	DESCRIPTION	MANUFACTURER	U-FACTOR
M01	244	1	3	28 1/2 "	32 "		HARVEY SLIMLINE WHITE VINYL SINGLE CASEMENT	HARVEY INDUSTRIES	0.3
M02	2842	3	3	33 1/2 "	5 3 "	YES	HARVEY SLIMLINE WHITE VINYL DOUBLE HUNG	HARVEY INDUSTRIES	0.3



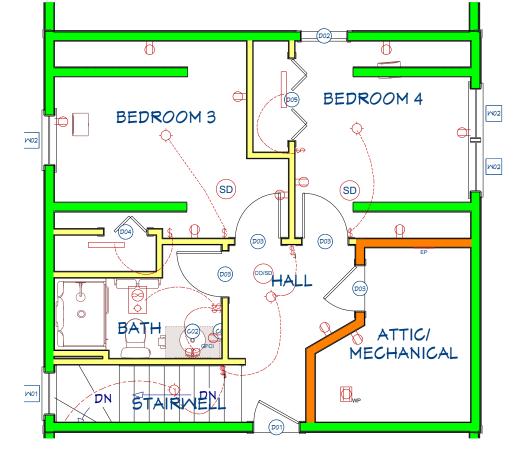





PROJECT

Caroline and Joon Pahk

93 Raymond Ave Somerville, MA 02144

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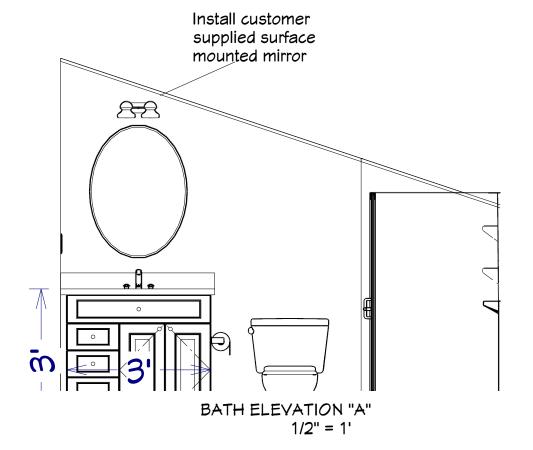
SCHEDULES AND ELECTRICAL LAYOUT


SCALE:


NOT TO SCALE

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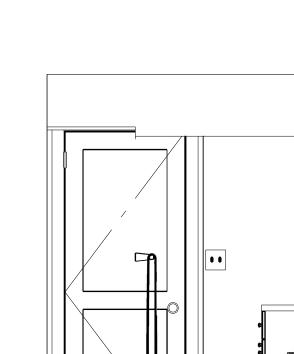
R.A. N.S. N.H. 11





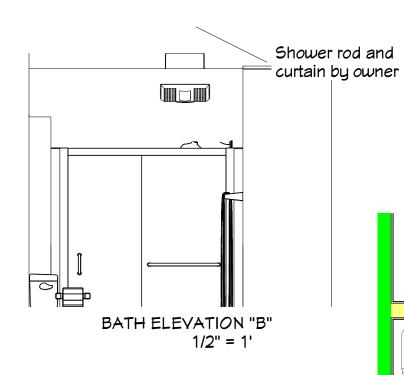

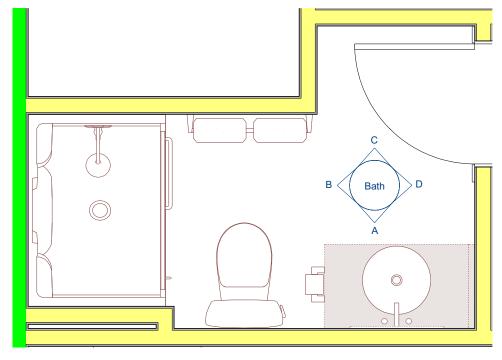BATH FLOOR PLAN 1/2" = 1'









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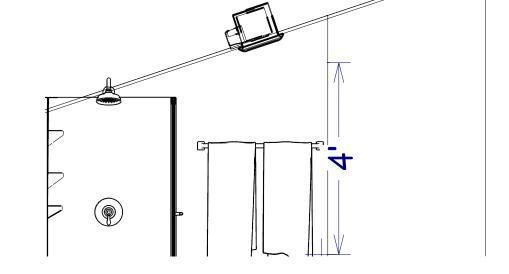
BATH INTERIOR ELEVATIONS

SCALE:

AS NOTED


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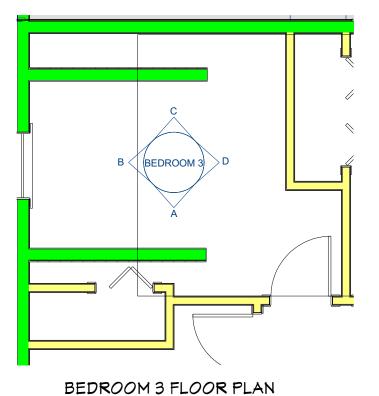
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BATH ELEVATION "C"

1/2" = 1'





1/4 = 1'

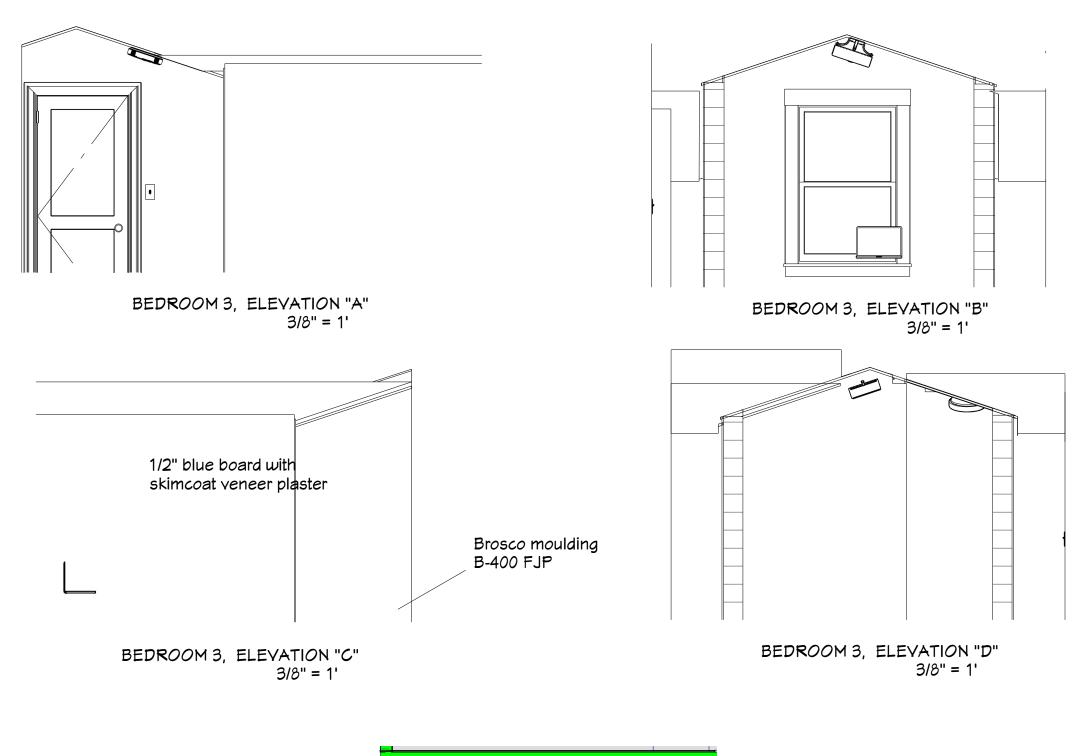



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BEDROOM 3 INTERIOR ELEVATIONS

SCALE:

AS NOTED

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R.A.

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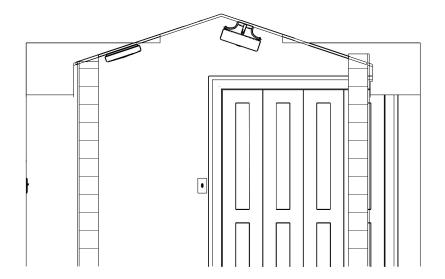
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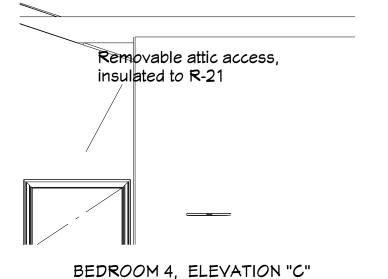


3/8" = 1'

3/8" = 1'




BEDROOM 4, ELEVATION "B" 3/8" = 1'





3/8" = 1'

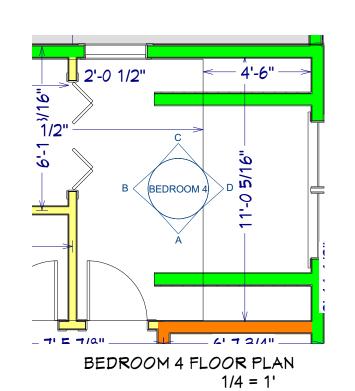



N.H.


FURNACE:

Goodman Model GMSS920402BNA, 40,000BTU gas furnace

CONDENSER:

Goodman Model gsx130181, 18,000BTU 1 1/2 ton

All duct work to be insulated with R-8 duct insulation

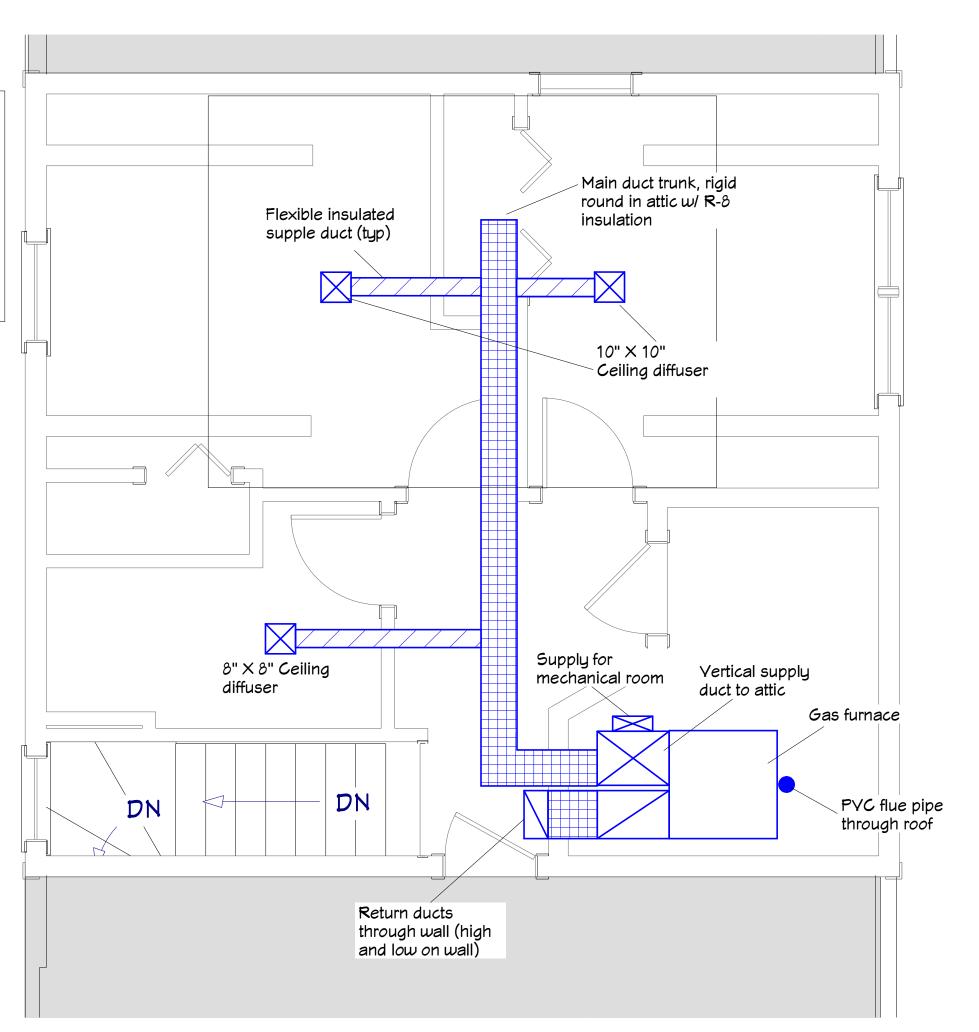



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HVAC PLAN


SCALE: 3/8" = 1'

DRAWN BY:

DRAWING #

1' A R.A. 15

N.S. N.H.

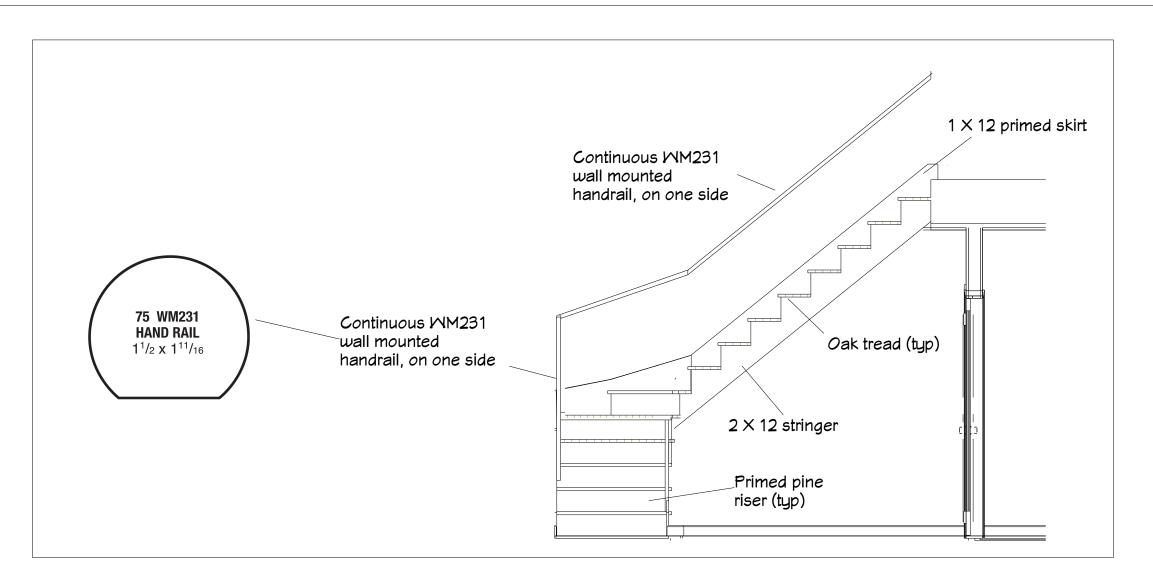

STAIRWAY FROM SECOND TO THIRD FLOOR

6) Install a continuous railing on one side of the staircase per plan.

7) Sand and finish treads with three coats of oil finish.


1) Frame stairs with (3) 2 X 12 kd stringers.


2) Frame stair winders per plan detail.

3) Install 3/4" unfinished oak treads.

5) Install primed1 X 12 skirt boards.

4) Install primed 1×8 risers.

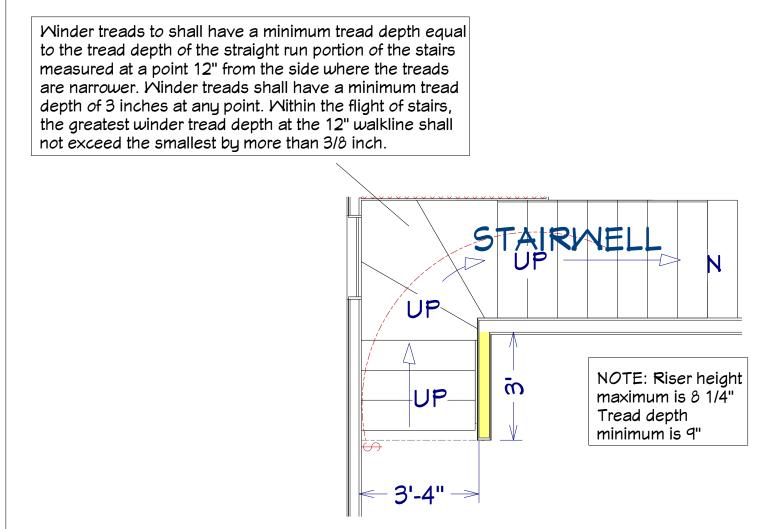

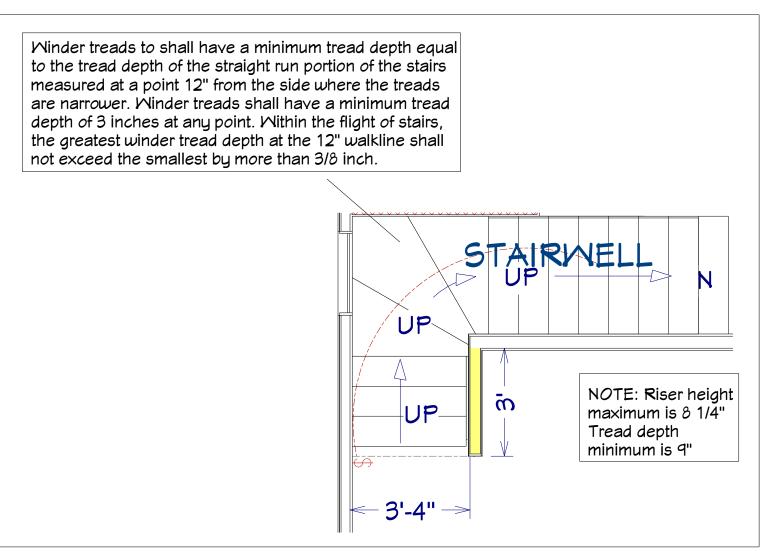



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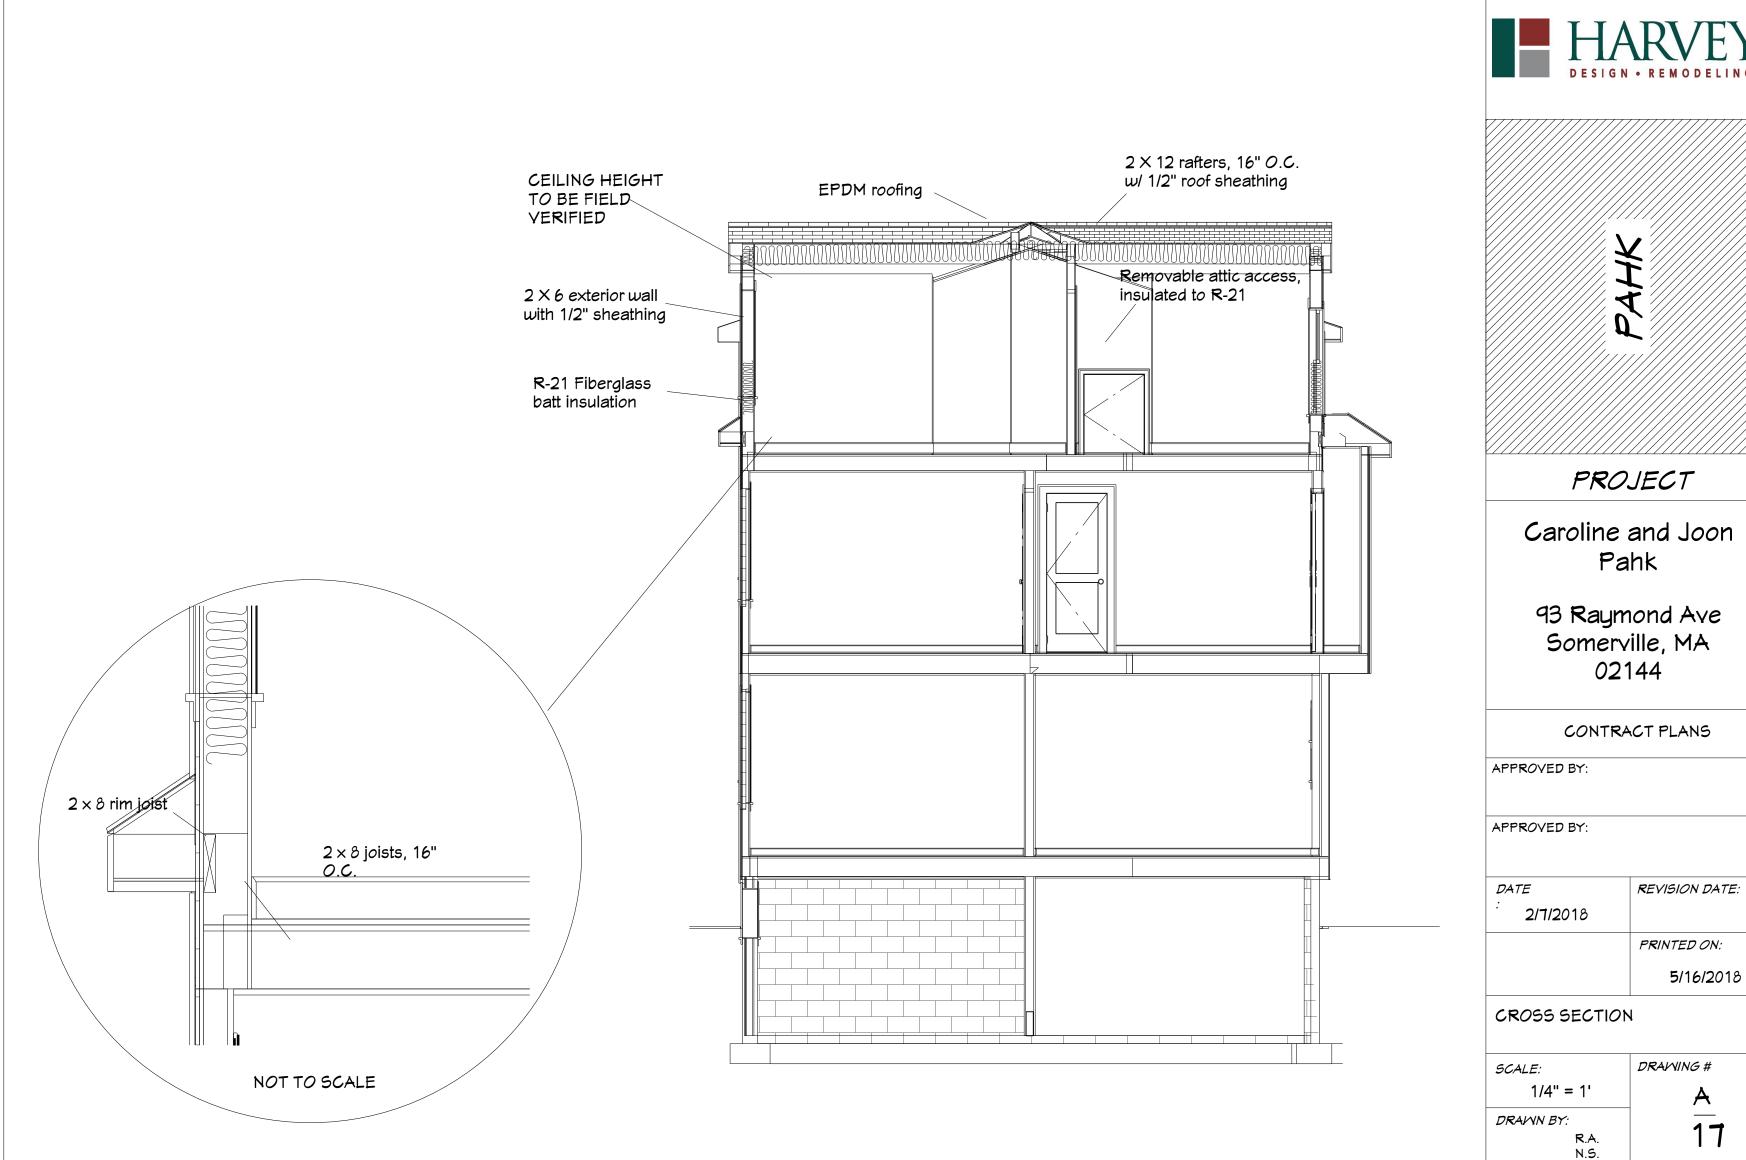
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STAIR DETAIL

DRAWING # SCALE: 3/8" = 1'

> N.S. N.H.

DRAWN BY: R.A.





N.H.



Product awareness

Showplace Wood Products wants your customers to be satisfied with the products they receive from us. Toward that goal, it is important that customers understand the inherent characteristics of woods and finishes.

Product awareness agreement

Inc. the undersigned (representing the dealership) acknowledges the responsibility of informing and educating each customer in the specific characteristics and inherent variability of woods and finishes. The undersigned has read and understands the information below. The undersigned understands that as new offerings become available it is their responsibility to explain new characteristics to the customer.

As an authorized dealer of Showplace Wood Products, The undersigned agrees not to hold Showplace Wood Products, Inc. responsible if a customer has not been made fully aware of the unique characteristics and inherent variability of their specific order, if those characteristics and variations are within the standards set by Showplace Wood Products, Inc.

> The undersigned must be either an Officer or Principal of the dealership.

Dealership	Location	
Officer or Principal name (print)		
Officer or Principal signature	Date	

Characteristics and variability

- Species: All woods naturally darken and mellow with age. This process varies with many factors, including the species, finish, and exposure to light. As a rule, cherry will darken more than most other woods. Certain species also exhibit more natural variation than others. Expect hickory to exhibit wide variation in grain, markings and coloration. Expect eucalyptus to show wide grain and color variation, and to darken considerably and rapidly.
- Stains: Wood has inherent variations in color, grain, and natural markings like mineral streaking. These variations will be more apparent in lighter stains. The most variation will be visible in the Natural finish, as this is clear sealer and topcoat only, with no base stain coloration. Also note that the application of a

glaze can tint the base stain, resulting in a different appearance from the base stain alone.

- · Hand application: Showplace specialty finishes are the result of hand crafting. As such, variation is to be expected, and is in fact considered an attribute. This includes glazed finishes with stain or paint, Charcoal, Black, Vintage and distressed offerings.
- . Unfinished: Unfinished orders are supplied without any stain, sealer or topcoat. Showplace cannot warranty finishes that are applied by the customer.

WARNING: Like trees or any other products made of wood, machining, sanding, sawing, or drilling this product may produce wood dust, a substance known to the State of California to cause cancer, Avoid inhaling wood dust or use a dust mask or other safeguards for personal protection.

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Finish advisory

Showplace Wood Products wants their dealers and end consumers to be completely satisfied with the products they receive. Therefore, it is important to understand the characteristics of finished wood and specialty finish offerings. Listed below are some areas that are important for you to understand in relation to woods and finishes. We require a signed copy of this advisory with any order of:

- -Any Natural finish, including exotic and SG woods, -Any painted finish, including ColorSelect, Charcoal and Black.
- -Any glazed, gray wash or distressed finish, -Any Vintage stained or painted finish, -Any unfinished order.
- Hand application: Showplace specialty finishes are the result of hand crafting. As such, variation is to be expected, and is in fact considered an attribute.
- Glazing: Showplace glazing is hand-applied to edge profiles and detail areas, and partially wiped away. This allows the glazing to collect, or "hang up" in these areas, in a naturally variable way. The inherent variation of hand glazing creates the appeal of this specialty finish process, and is not a defect or reason. for replacement. Backs of doors and headers do not receive glazing. Styles without edge detail, such as slab doors, will not show the glazing effect to any significant degree.
- · Gray wash, distressing, paints, Vintage: These Showplace specialty finishes are hand applied over the entire door and drawer front surfaces, and by their nature, will leave different colorations and/or degrees of distressing throughout the surface and detail profiles of the cabinetry. Each door, frame and header will have its own unique look due to its different characteristics and the the inherent variability of hand application. This is the individual beauty that defines these specialty finishes, and is not a defect or reason for replacement. Backs of doors and headers do not receive specialty finish elements.

- Natural Finish: Cabinets produced with Natural finish will have clear sealer and top coat applied, but no base coat color of stain. This allows you to enjoy seeing the natural variations in the wood. All woods have many color characteristics, grain patterns, and certain markings that are innate in each species, and a Natural finish allows them to show more than a stained or painted finish does. Such variations should not be thought of as defects or imperfections; this is the beauty of wood.
- Unfinished: On request, Showplace will supply unfinished cabinetry. Unfinished orders are produced without any stain, sealer, or top coat applications. Showplace cannot warranty finishes that are applied by the customer.

We have read the above information and understand the characteristics of the finishes. We understand that our order may vary slightly from one cabinet to another, and that this is a characteristic of wood.

Signatures:	
Dealer:	
Dealer P.O.:	
Customer:	
Date:	

Please sign completed form and submit with order (copy as needed).

Dealers may choose to complete the blanket product awareness agreement which can be placed on file with Showplace in lieu of completing a Finish Advisory for individual orders.

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APPROVED BY:				
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	PRINTED ON:			
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PRODUCT AWARENESS				

DRAMING #

SCALE:

DRAWN BY:

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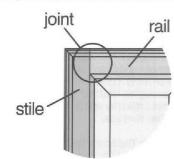
PRODUCT AMARENESS




about Showplace paints

- Paint vs. stain: Showplace painted finishes have the solid-color appeal of standard painted cabinetry, but are actually created through a multi-layer process that includes final topcoating with an oven-baked varnish, similar to our stains. The Showplace finish process actually yields an end result that is more durable than many standard "paints."
- Sheen: All painted finishes are offered in your choice of satin sheen (25 degree mid-gloss) and matte sheen (10 degree low-gloss). Prior to 2013, all Showplace standard paints were finished in satin sheen.
- End grain: In areas where the end grain of the wood is exposed the edges of doors, for example paints will be able to penetrate even deeper, especially in red oak and hickory. This means end grain areas may appear darker and more variable than flat surfaces like rails, stiles or center panels. This is a natural characteristic of the finish process and is not considered a flaw.
- Distressing: All Charcoal orders include hand distressing. There will be some variation in the amount, location and types of distressing features. Also, due to the nature of the Charcoal finish, the "rub-through" component of distressing is very evident, especially with the Natural undertone. Since rub-through is the result of a hand process, a degree of variation is to be expected. The Charcoal photographs shown in our literature and websites represent an average level of distressing. Your cabinetry can be expected to vary somewhat from this average. Variations in distressing should be considered part of Charcoal's character, not flaws.

 Joinery: You can expect to see some joinery lines in your cabinetry. One common place for joinery to be visible is where the stile and rail meet on a cabinet door, drawer header or frame. This is a natural characteristic of the finish process, and not considered a flaw.



• Changes over time: Wood is "hygroscopic," meaning it naturally absorbs and releases moisture in its environment. These changes in moisture content may result in small dimensional changes that can happen gradually over time, or happen suddenly with seasonal changes or changes in humidity within the home. When these natural dimensional changes occur, joinery lines can appear that were not visible before. For instance: As wood swells and contracts due to seasonal humidity changes, a joint where a stile and rail meet can open up slightly, showing a line that was not previously visible. When exposed to drier air, solid door center panels will contract, exposing a visible line next to the stile until moisture is restored. Paint grade doors utilize MDF for the center panel which minimizes or eliminates this. These are inherent characteristics of wood, and are not considered flaws.

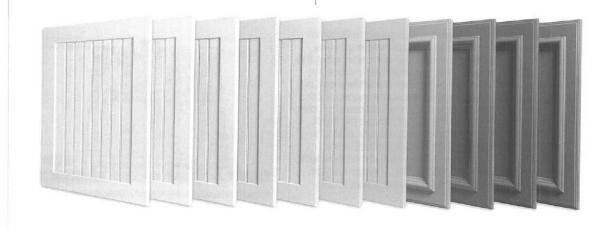

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PRODUCT AWARENESS

SCALE: DRAWING #

N.S. N.H.

DRAWN BY: R.A. <u>1</u>9

5/16/2018

PRODUCT AMARENESS